GENERAL NOTES

- ALL DIMENSIONS ARE IN MILLIMETERS.
- DIMENSIONS TAKE PREFERENCE OVER SCALE AND ARE TO STRUCTURE NOT FINISH.
- CHECK AND VERIFY DIMENSIONS AND CONFIRM ANY EXISTING DIMENSIONS MARKED.
- WORK SHALL COMPLY WITH THE BCA AND ALL RELEVANT CURRENT AUSTRALIAN STANDARDS. ANY OUTDATED STANDARDS LISTED IN THESE NOTES ARE TO BE TAKEN TO REFER TO THE CURRENT EDITION.
- MANUFACTURES SPECIFICATION MEANS A CURRENT APPROVED SPECIFICATION FOR USE UNDER CONDITIONS APPLICABLE. THESE NOTES ARE NOT EXHAUSTIVE AND SHALL NOT BE USED AS A SUBSTITUTE FOR NATIONAL CONSTRUCTION CODE REQUIREMENTS. DO NOT SCALE FROM DRAWINGS. DIMENSIONS ONLY TO BE USED. ALL MEASUREMENTS TO BE CONFIRMED ONSITE PRIOR.

ALL WORK SHALL COMPLY WITH THE NATIONAL CONSTRUCTION CODE 2022 AND ALL RELEVANT AUSTRALIAN STANDARDS INCLUDING BUT NOT LIMITED TO:

AS 1562 - DESIGN AND INSTALLATION OF SHEET ROOF AND WALL CLADDING

AS 4100 - STEEL STRUCTURES

AS 1562 - DESIGN & INSTALLATION OF SHEET & WALL

CLADDING - METAL

AS 2870 - RESIDENTIAL SLABS AND FOOTINGS.

AS 2904 - DAMP PROOF COURSES AND FLASHINGS

AS 3500 - PLUMBING & DRAINAGE

AS 3600 - CONCRETE STRUCTURES

AS 3660 - PROTECTION OF BUILDINGS FROM SUBTERRANEAN TERMITES.

AS 3740 - WATERPROOFING OF WET AREAS IN RESIDENTIAL **BUILDINGS**

AS 3959:2018 - CONSTRUCTION OF BUILDINGS IN BUSHFIRE PRONE AREAS

AS 4055 - WIND LOADINGS FOR HOUSING

AS 4600 - COLD FORMED STEEL STRUCTURES

AS 4687 - TEMPORARY FENCING AND HOARDINGS GENERAL REQ.

BUILDER TO PROVIDE ALL LABOR, MATERIAL, FITTINGS, PLANT, TOOLS, PERMITS . INSURANCE . ETC NECESSARY FOR THE PROPER COMPLETION

OF THE WORK AND ENSURE THAT ALL TRADES ARE THE BEST OF THEIR RESPECTIVE KINDS. BUILDER IS TO VISIT THE SITE AND INFORM HIMSELF

OF SCOPE OF WORK PRIOR TO COMMENCING. FOLLOW FIGURED DIMENSIONS ON THE DRAWINGS CHECK AND VERIFY DIMENSIONS PRIOR

TO STARTING ANY WORK. MATERIAL & WORKMANSHIP TO BE IN ACCORDANCE WITH THE BUILDING CODE OF AUSTRALIA. THE ACT APPENDIX & ALL OTHER RELEVANT CODES BUILDER SHALL BE RESPONSIBLE FOR THE GENERAL WATER TIGHTNESS OF THE ENTIRE WORKS IN ALL TRADES.

SITE MANAGEMENT DURING CONSTRUCTION:

ALL BUILDERS AND CONTRATORS TO MANAGE ASITE IN ACCORDANCE WITH THE SEDIMENT & EROSION MEASURES ON THE SITE PLAN. SEDIMENT CONTROL BARRIER TO BE ERECTED PRIOR TO ANY EXCAVATION WORKS COMMENCING.

SITE:

ALL STORMWATER & DRAINAGE TO BE COMPLIANT WITH NCC 2019 PART 3 AND AS/NZ3600 GROUND SURFACE TO BE SLOPED SO AS PONDING CANNOT OCCUR NEAR BUILDING. DISH DRAINS AND AG PIPES TO BE USED AS NECCESSARY.

REFER TO ENGINEERING SPECIFICATION & DRAWINGS FOR FOOTINGS. THE BUILDER & SUBCONTRACTOR SHALL ENSURE ALL DRAINS, PIPES ETC TO BE LOCATED SUFFICIENT DISTANCE FROM ANY STRUCTURE TO PREVENT GENERAL MOISTURE, DAMPNESS, WEAKENING AND UNDERMINING OF ANY BUILDING. NO JOINTS UNDER SLAB OR FOOTINGS.

ROOF:

- TRUSSES AT 900MM CENTERS IN ACT AND 600MM CENTERS IN NSW AND
- FIX MANUFACTURERS SPECIFICATIONS.
- LINTEL SIZE TO TRUSS MANUFACTURERS CHART.
- STEEL ROOF AS SELECTED.
- METAL FASCIA & GUTTER AS SELECTED.
- PLASTER INTERNAL LINING. WALL FRAMING TO ALL ROOMS TO BE COVERED JOINTS BEING BACKED WITH EITHER NOGGINS OR STUDS AS

REQUIRED BY MANUFACTURER.

- ALL THINGS SHALL BE SECURELY FIXED PLASTER BOARD (MIN 10MM THICK) WALL & CEILING LINING.
- FIBROUS CEMENT SHEET LINING TO EAVES.

TERMITE TREATMENT:

- -TERMITE BARRIER TO BE INSTALLED IN ACCORDANCE WITH AS3660.
- -TERMITE PROTECTION TO BE INSTALLED IN A RETICULATION SYSTEM

BUSHFIRE PRONE AREAS:

- SPECIFIES THE CONSTRUCTION REQUIREMENTS FOR BUILDINGS BUILT IN BUSHFIRE-PRONE AREAS IN ORDER TO IMPROVE THE BUILDINGS RESISTANCE TO BUSHFIRE ATTACK INCLUDING FROM BURNING EMBERS. RADIANT HEAT AND FLAME CONTACT OR A COMBINATION OF THESE.

DRAINAGE & PLUMBING:

- PROVIDE ALL NECESSARY DRAINAGE REQUIRED FOR THE DISCHARGE &

CONNECTIONS TO APPROPRIATE TIES OF STORMWATER & OTHER DRAINAGE SERVICES AS REQUIRED FOR THE PROPER FUNCTIONING OF FACILITIES AS REQUIRED BY THE APPROPRIATE AUTHORITIES PROVIDE ALL AGRICULTURAL DRAINS AS REQUIRED TO DIVERT WATER & MOISTURE, WHICH MAY CAUSE SEEPAGE TO THE BUILDING STRUCTURE.

-GROUND SURFACE TO BE SLOPED SO AS PONDING CANNOT OCCUR **NEAR**

BUILDING, DISH DRAINS AND AG PIPES TO BE USED WHEN NECESSARY.

- ALL STORMWATER & DRAINAGE TO BE COMPLIANT WITH NCC 2019 PART 3 AND AS/NZ3600.

STRUCTURAL STEELWORK:

- -ALL STEELWORK TO COMPLY WITH AS 4100-2020.
- ALL DIMENSIONS TO BE CHECKED ON SITE BEFORE FABRICATION COMMENCES.
- ALL WELDING TO COMPLY WITH AS 1554 2011 PARTS 1 & 2.
- ALL WELDS TO DEVELOP FULL STRENGTH OF MEMBERS JOINED U.O.N.
- FULLY SEAL ALL HOLLOW SECTIONS USING 5mm PLATES WHERE NECESSARY.
- PROVIDE ALL CLEATS, BRACKETS HOLES, ETC. NOT SHOWN BUT **NECESSARY TO**

COMPLETE THE BUILDING.

- UNLESS OTHERWISE SHOWN, ALL BOLTED CONNECTIONS ARE TO DEVELOP

FULL STRENGTH OF MEMBERS JOINED.

- STEEL BEAMS TO BE FABRICATED WITH NATURAL CAMBER UP.
- UNLESS OTHERWISE NOTED USE:
- (A) 10mm THICK GUSSET FIN AND END PLATES AND 2-M16 8.8/S BOLTS OR (B) 6mm CONTINUOUS SP FILLET WELD.
- ALL BOLTED CONNECTIONS TO BE BOLTING CATEGORY 8.8/S BOLTS U.O.N.
- PROVIDE TEMPORARY BRACING DURING ERECTION.
- USE 1:2 CEMENT SAND GROUT UNDER THE ALL SEATING AND BASE **PLATES**

ENSURING THE SPACE UNDER THE PLATES IS COMPLETELY FILLED.

- WHERE MASONRY WALLS ABUT OR ADJACENT TO STEEL COLUMNS WELD A

VERTICAL R10 ROD TO COLUMN. LENGTH OF WELD TO BE 25mm EACH SIDE OF

ROD EVERY 350mm. PROVIDE 5mm CLEARANCE BETWEEN ROD AND COLUMN FACE.

- EXTERNAL STEELWORK TO BE HOT DIPPED GALVANISED.
- COLD FORMED SECTIONS TO CONFORM TO AS 1397 2011- G450 (450MPa MIN YIELD STRESS).

First Sheds Pty Ltd

ARN: 96 612 137 489

Ph: 6242 5927 M: 0431 229 355 sales@firstsheds.com.au www.firstsheds.com.au 48 Hoskins Street Mitchell 2911



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		DRAWN	DATE	PROJECT MANAGER:
DESCRIPTION	REV			IODDANI ELVAIN
FIRST ISSUE	Α	LD	20.03.2025	JORDAN FLYNN
AMENDS	В	LD	24.03.2025	
				SIGN & DATE:

ANDREW PIKE & SAM PAGE 0411 601 373 SIGN & DATE:

CLIENT:

PROPOSED BIG G 9000 SPAN x 3500 EAVE x 16000 LONG


PROJECT TITLE:

PROJECT ADDRESS:	DRAWING NAME:	
16 WALGROVE R NSW 2582	ROAD, MANTON	ARCHIT SPECS
PROJECT CONSULTANT(S):	PROJECT MANAGER:	SCALE:

JORDAN FI YNN


NIC DARMODY

ARCHITECTURAL **SPECS** DRAWING No. NTS @ A3 A.01

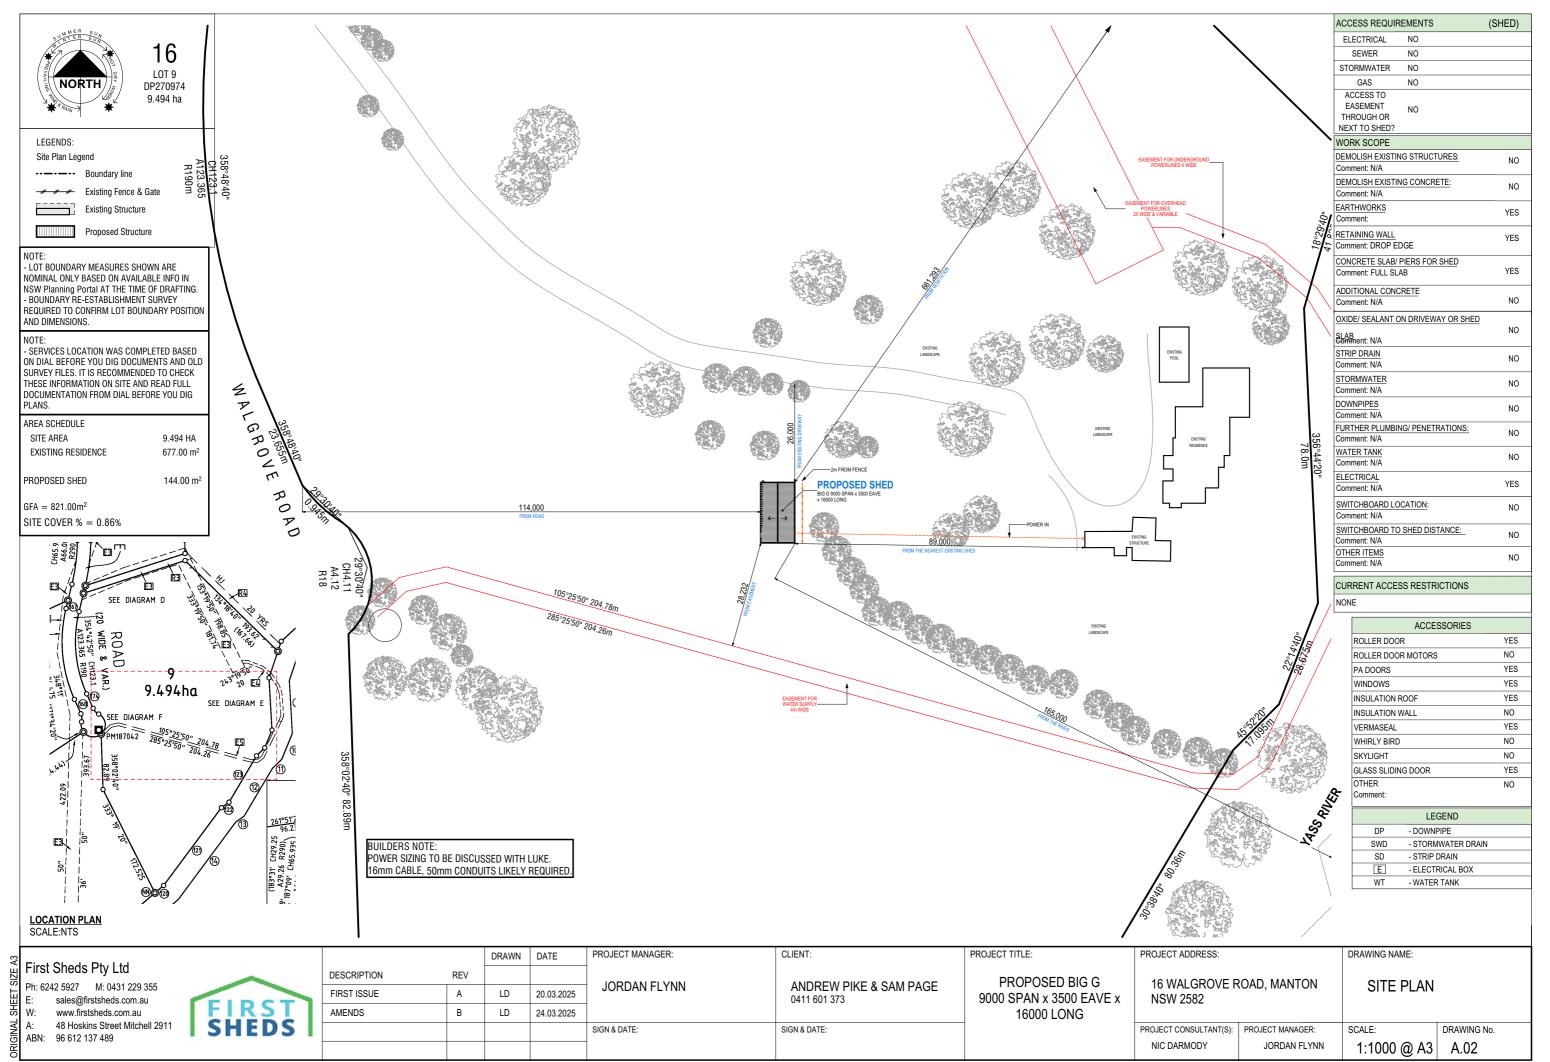



EAST ELEVATION

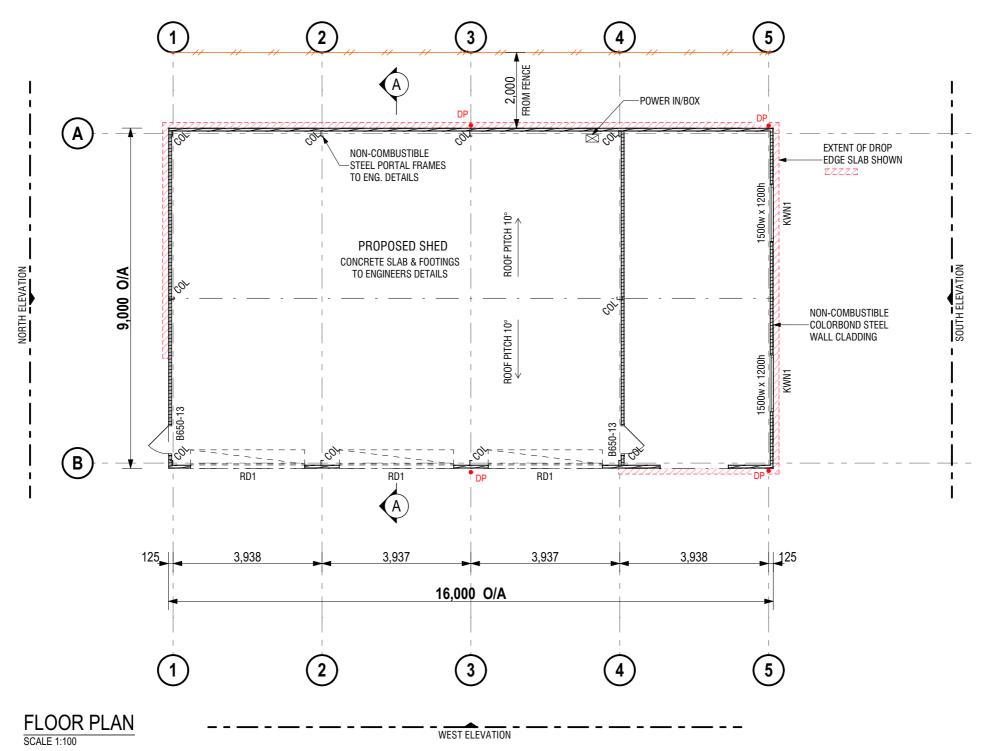

CONSTRUCTION NOTE:

- · FINAL RL TO BE CONFIRMED ON SITE PRIOR TO CONSTRUCTION.
- DRAWINGS TO BE READ IN CONJUNCTION WITH ALL CONSULTANTS DRAWING SETS.
- FOR ALL STRUCTURAL DETAILS (STEEL PROFILES, FIXTURES, FITTINGS, FOOTINGS, PIERS & CONCRETE SLAB ETC.) REFER TO CONSULTING STRUCTURAL ENGINEERS SPECIFICATIONS.
- · ALL FOOTINGS & PIERS TO BE TAKEN DOWN TO SOLID GROUND.
- · ALL CONSTRUCTION TO BE COMPLIANT WITH AUSTRALIAN NATIONAL CONSTRUCTION CODE, RELEVANT CONSTRUCTION MANUALS & STANDARDS.
- · ALL DOWNPIPES MUST LEAD TO EITHER A WATER STORAGE TANK OR BE DISCHARGED AND ATTACHED TO STORM WATER WITH LOCAL GOVERNMENT AUTHORITY APPROVAL.

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Ph: 6242 5927 M: 0431 229 355
E: sales@firstsheds.com.au
W: www.firstsheds.com.au
A: 48 Hoskins Street Mitchell 2911
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DESCRIPTION	REV			IODDANI EL VAINI	AND DEW DIVE & CAM DAGE
FIRST ISSUE	Α	LD	20.03.2025	JORDAN FLYNN	ANDREW PIKE & SAM PAGE 0411 601 373
AMENDS	В	LD	24.03.2025		
				SIGN & DATE:	SIGN & DATE:

PROJECT TITLE:

PROPOSED BIG G
9000 SPAN x 3500 EAVE x
16000 LONG

PROJECT ADDRESS:

16 WALGROVE ROAD, MANTON NSW 2582

PROJECT CONSULTANT(S): PROJECT MANAGER:

JORDAN FLYNN


NIC DARMODY

PLOOR PLAN

SCALE: DRAWING NO.

A.03

1:100 @ A3

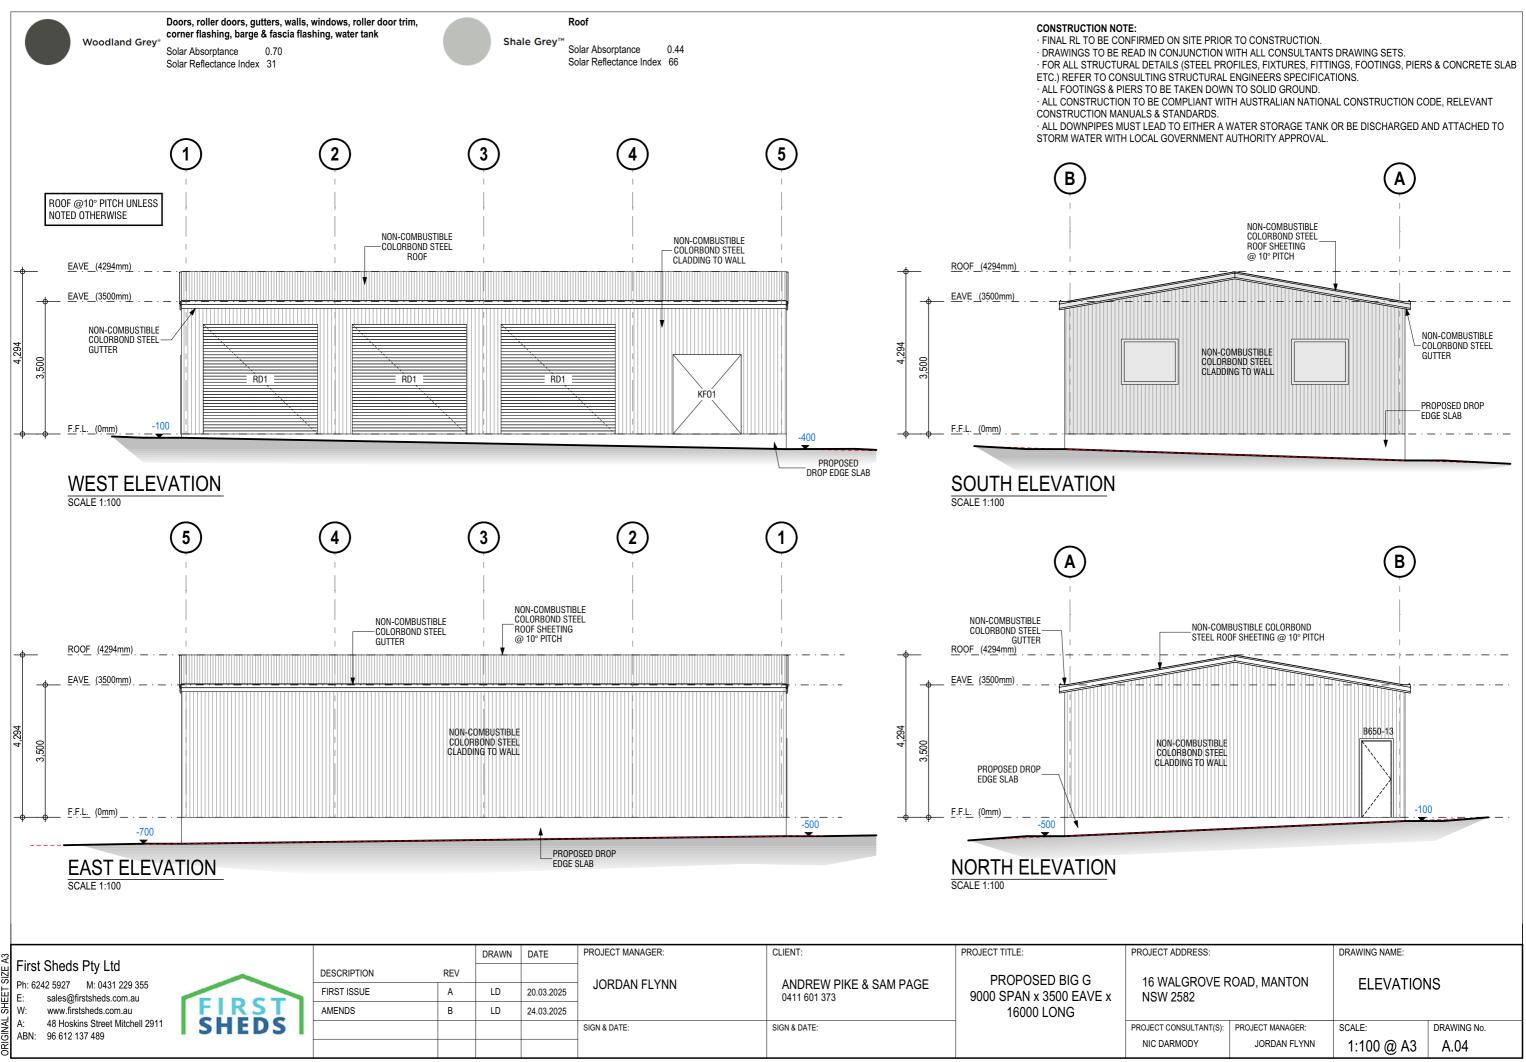

Woodland Grey®

Doors, roller doors, gutters, walls, windows, roller door trim, corner flashing, barge & fascia flashing, water tank

Solar Absorptance 0.70 Solar Reflectance Index 31



SCALE 1:100

Roof

Shale Grey™ Solar Absorptance 0.44 Solar Reflectance Index 66

(B) NON-COMBUSTIBLE NON-COMBUSTIBLE COLORBOND STEEL--COLORBOND STEEL GUTTER ROOF SHEETING ROOF (4294mm) ___ EAVE (3500mm) NON-COMBUSTIBLE -STEEL PORTAL FRAMES TO ENG. DETAILS NON-COMBUSTIBLE STEEL PORTAL FRAMES-TO ENG. DETAILS PROPOSED SHED <u>F.F.L.</u> (0<u>m</u>m) _ REFER TO ENGINEERING'S DETAILS FOR CONCRETE FOOTINGS, WATERPROOFING, SLAB & SAND PAD REQUIREMENTS **SECTION A-A**

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_			DRAWN	DATE	PROJECT MANAGER:	CLIENT:	PROJECT TITLE:	PROJECT ADDRESS
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	DESCRIPTION	REV			IODDANI EL VNN	ANDDEW DIVE & CAM DAGE	PROPOSED BIG G	16 WALGRO
	FIRST ISSUE	Α	LD	20.03.2025	JORDAN FLYNN	ANDREW PIKE & SAM PAGE 0411 601 373	ANDREW FIRE & SAW FAGE	NSW 2582
	AMENDS	В	LD	24.03.2025			16000 LONG	
					SIGN & DATE:	SIGN & DATE:		PROJECT CONSULTAN
								NIC DARMODY

	PROJECT ADDRESS:		-
(16 WALGROVE F NSW 2582	ROAD, MANTON	
	PROJECT CONSULTANT(S):	PROJECT MANAGER:	5

CONSTRUCTION NOTE:

CONSULTANTS DRAWING SETS.

CONSTRUCTION.

SPECIFICATIONS.

GROUND.

APPROVAL.

· FINAL RL TO BE CONFIRMED ON SITE PRIOR TO

· DRAWINGS TO BE READ IN CONJUNCTION WITH ALL


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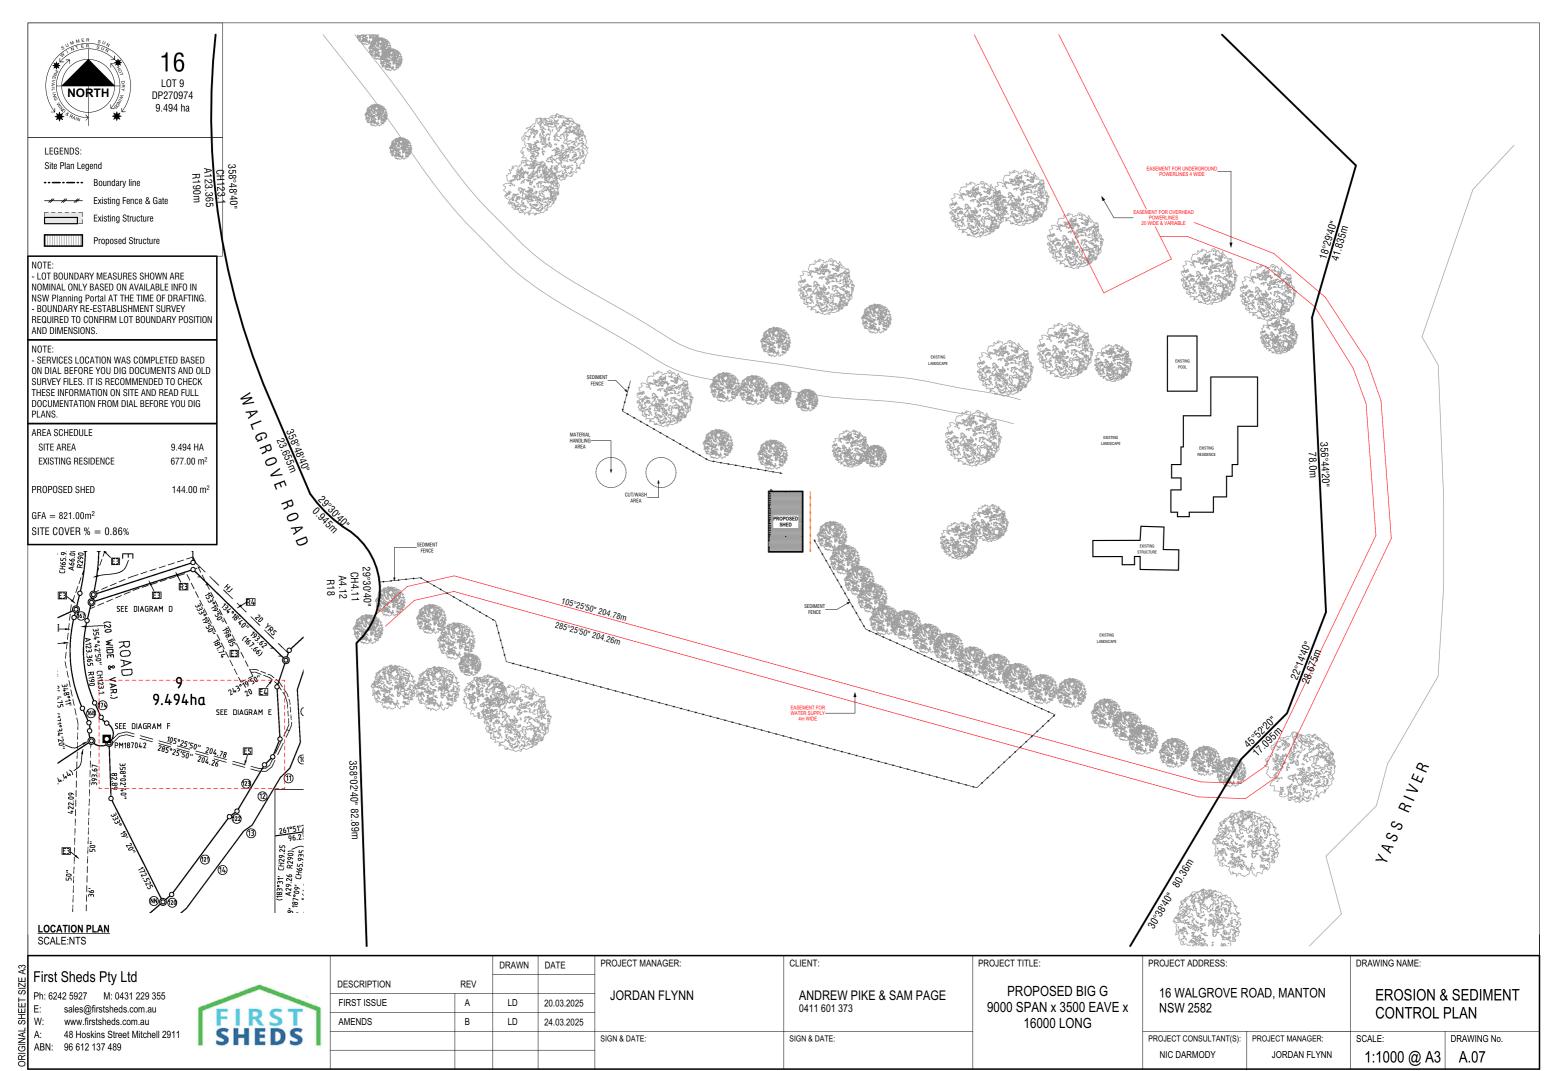
· ALL FOOTINGS & PIERS TO BE TAKEN DOWN TO SOLID

NATIONAL CONSTRUCTION CODE, RELEVANT CONSTRUCTION MANUALS & STANDARDS. · ALL DOWNPIPES MUST LEAD TO EITHER A WATER STORAGE TANK OR BE DISCHARGED AND ATTACHED TO STORM WATER WITH LOCAL GOVERNMENT AUTHORITY

· ALL CONSTRUCTION TO BE COMPLIANT WITH AUSTRALIAN

DRAWING NAME: **SECTION** SCALE: DRAWING No. JORDAN FLYNN 1:100 @ A3 A.05



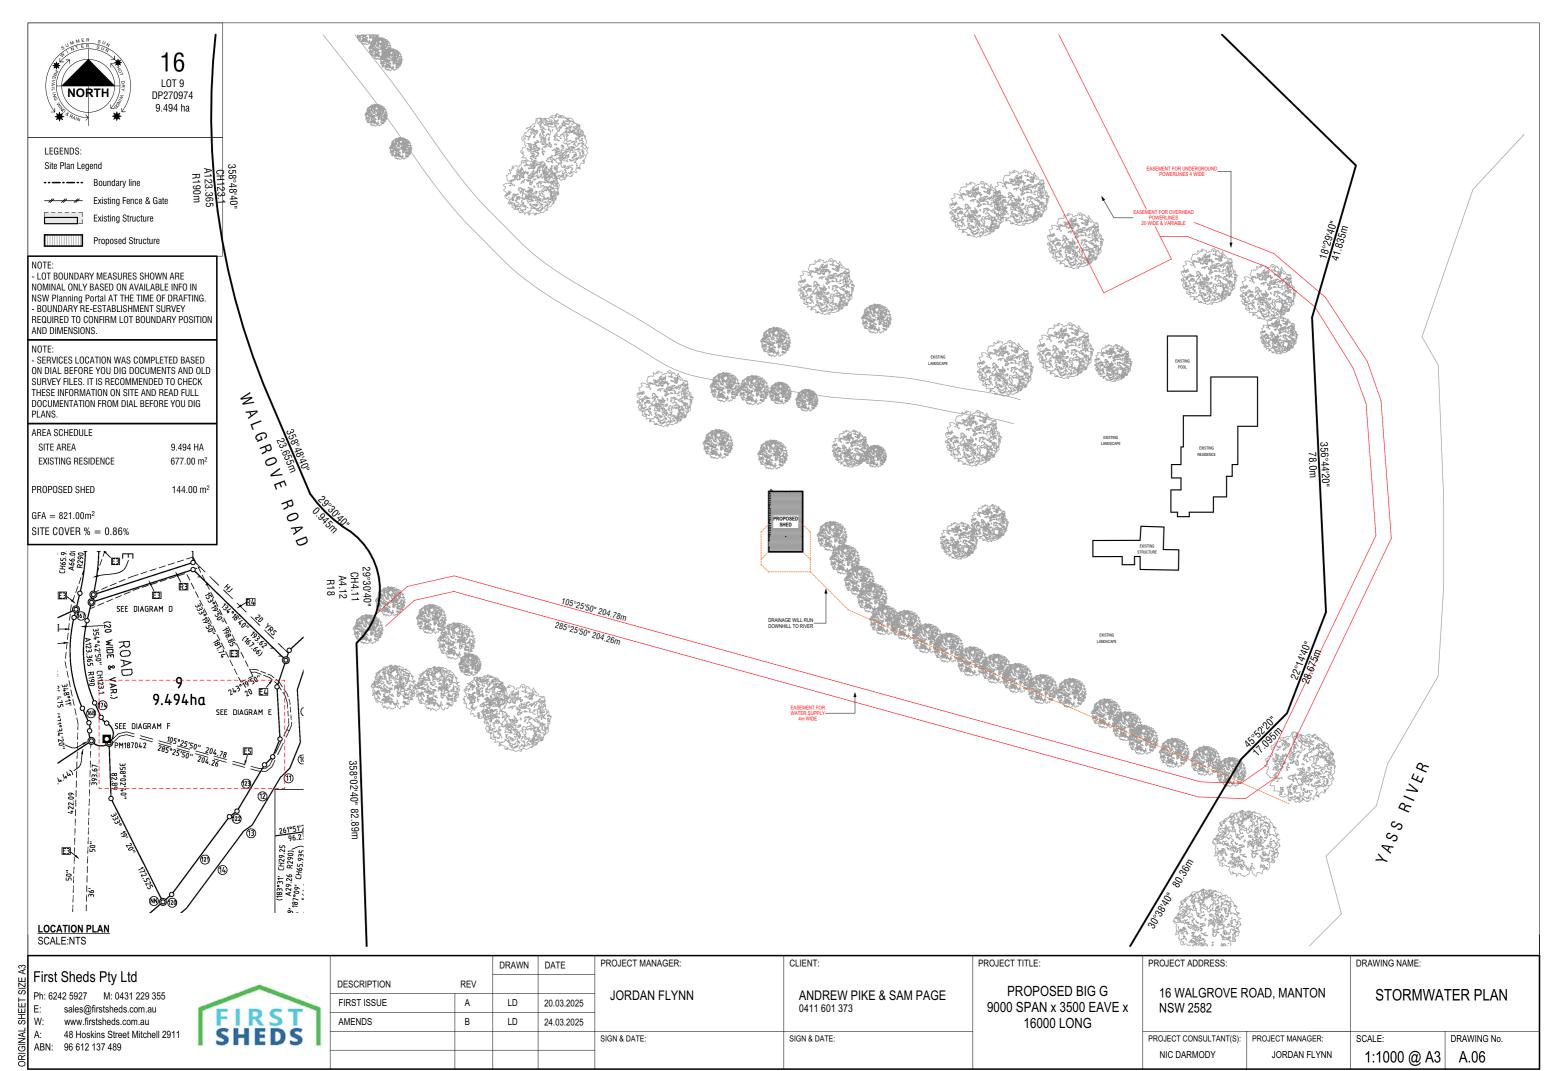



(2)(3)(4)**∢**A) POWER IN/BOX (A)EXTENT OF DROP NON-COMBUSTIBLE
-STEEL PORTAL FRAMES -EDGE SLAB SHOWN TO ENG. DETAILS KWN1 PROPOSED SHED CONCRETE SLAB & FOOTINGS O/A TO ENGINEERS DETAILS 9,000 NON-COMBUSTIBLE -COLORBOND STEEL ROOF PITCH 10° WALL CLADDING B RD1 RD1 16,000 O/A 3

WEST ELEVATION

CONSTRUCTION NOTE:

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DRAWING NAME:

1:100 @ A3

SCALE:

JORDAN FLYNN

PUBLIC FLOOR PLAN

DRAWING No.

A.08

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FLOOR PLAN

SCALE 1:100

		DRAWN	DATE	PROJECT MANAGER:	CLIENT:	PROJECT TITLE:	PROJECT ADDRESS:		
DESCRIPTION	REV			IODDANI EL VAINI	ANDDEW DIVE & CAM DAGE	PROPOSED BIG G	16 WALGROVE ROAD, MANTON		
FIRST ISSUE	Α	LD	20.03.2025	JORDAN FLYNN	ANDREW PIKE & SAM PAGE 0411 601 373	9000 SPAN x 3500 EAVE x			
AMENDS	В	LD	24.03.2025			16000 LONG			
				SIGN & DATE:	SIGN & DATE:		PROJECT CONSULTANT(S):	PROJECT MANAGER:	
							NIC DARMODY	JORDAN FLYNN	

CONSTRUCTION NOTES - SEPCIFICATIONS FOR BAL 12.5 NOTE: BUSH FIRE ZONE - BAL 12.5

STRUCTURE SHALL BE CONSTRUCTED IN ACCORDANCE WITH THE BUSH FIRE ATTACK LEVEL (BAL - 12.5) AS PER AUSTRALIAN STANDARDS 3959

Service Pipes (Water & Gas)

Above ground , water and gas supply pipes shall be metal and pipes buried to a depth of not less than 300 mm below FGL.

Eaves Lining , Fascias and Gables

- Gables shall comply with the requirements of External Walls above
- Eaves penetrations shall be protected the same as for roof penetrations
- Eaves ventilation openings greater than 3mm shall be fitted with ember guards made of noncombustible material or a mesh or perforated sheet with a maximum aperture of 2mm made of corrosion resistant steel, bronze or aluminium
- Joints in eaves linings, fascias and gables may be sealed with plastic joining strips or timber storm moulds

External Walls

That part of an external wall surface which is less than 400 mm from the ground to be of non-combustible material or fibre cement external cladding a minimum of 6 mm in thickness. All joins in the external surface material of walls shall be covered , sealed , overlapped , backed or butt jointed to prevent gaps greater than 3mm. Alternatively sarking- type material can be applied over the frame prior to fixing any external cladding. (a reference to sarking is a reference to the material being either non -combustible or having a flammability index of less than 5 when tested to AS 1530.2)

Vents & weep holes in external walls shall be screened with a mesh with a maximum aperture of 2mm, made of corrosion resistant steel, bronze or aluminium, except where the vents & weepholes are less than 3mm or located in the external wall of a subfloor.

External Doors - Roller Doors .

- The lower portion of a vehicle access door that is within 400 mm of the ground when the door is closed shall be made from-
 - (i) Non-combustible material; or
 - (ii) Bushfire-resisting timber (refer to the table at the end of this
- Roller doors shall have guide tracks with a maximum gap no greater than 3 mm and shall be fitted with a nylon brush that is in contact with the
- Vehicle access doors shall not include ventilation slots.

-Roof sheets and roof covering accessories shall be noncombustible

-The roof /wall junction shall be sealed to prevent openings greater than

2mm either by the use of fascia and eaves linings or by sealing between the top of the wall and the underside of the roof and between the rafters at the line of the wall

-Roof ventilation openings, such as gables and roof vents, shall be fitted with ember guards made of non -combustible material or a mesh or perforated sheet with a maximum aperture of 2 mm made of corrosion resistant steel , bronze or aluminium

-Sheet roofs shall have foil backed insulation blankets installed over the battens

Gutters and Downpipes

Roofs

-Box gutters shall be non-combustible and flashed at the junction with the roof with non-combustible material -This standard does not provide specific material requirements for downpipes or gutters other than box gutters as above

-Flooring and Sub Floor Supports to Principal Building

-Concrete Slab on Ground

External Doors - Side Hung Doors

- Doors shall be -

(A) non-combustible: or

(B) a solid timber, laminated timber or reconstituted timber door. having a minimum thickness of 35 mm for the first 400 mm

above the threshold: or

(C) a door, including a hollow core door, with a non-combustible kick plate on the outside for the first 400 mm above the

threshold:

- Doors shall be tight-fitting to the door frame and to an abutting door, if applicable.

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PROJECT MANAGER:	CLIENT:
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SIGN & DATE:	SIGN & DATE:

BUSHFIRE CONSTRUCTION PLAN - BAL 12.5

SCALE 1:100

DATE

20.03.2025

24.03.2025

PROPOSED BIG G
9000 SPAN x 3500 EAVE x
16000 LONG

PROJECT TITLE:

PROJECT ADDRESS.	
16 WALGROVE F NSW 2582	ROAD, MANTON
PROJECT CONSULTANT(S):	PROJECT MANAGER:

BUSHFIRE		
CONSTRUCTION PLANS		
SCALE.	DRAWING No	

A.09

DRAWING NAME:

DJECT CONSULTANT(S):	PROJECT MANAGER:	SCALE:
NIC DARMODY	JORDAN FLYNN	1:100 @ A3